
These plans are not to be utilized for construction. They are for illustration purposes only.

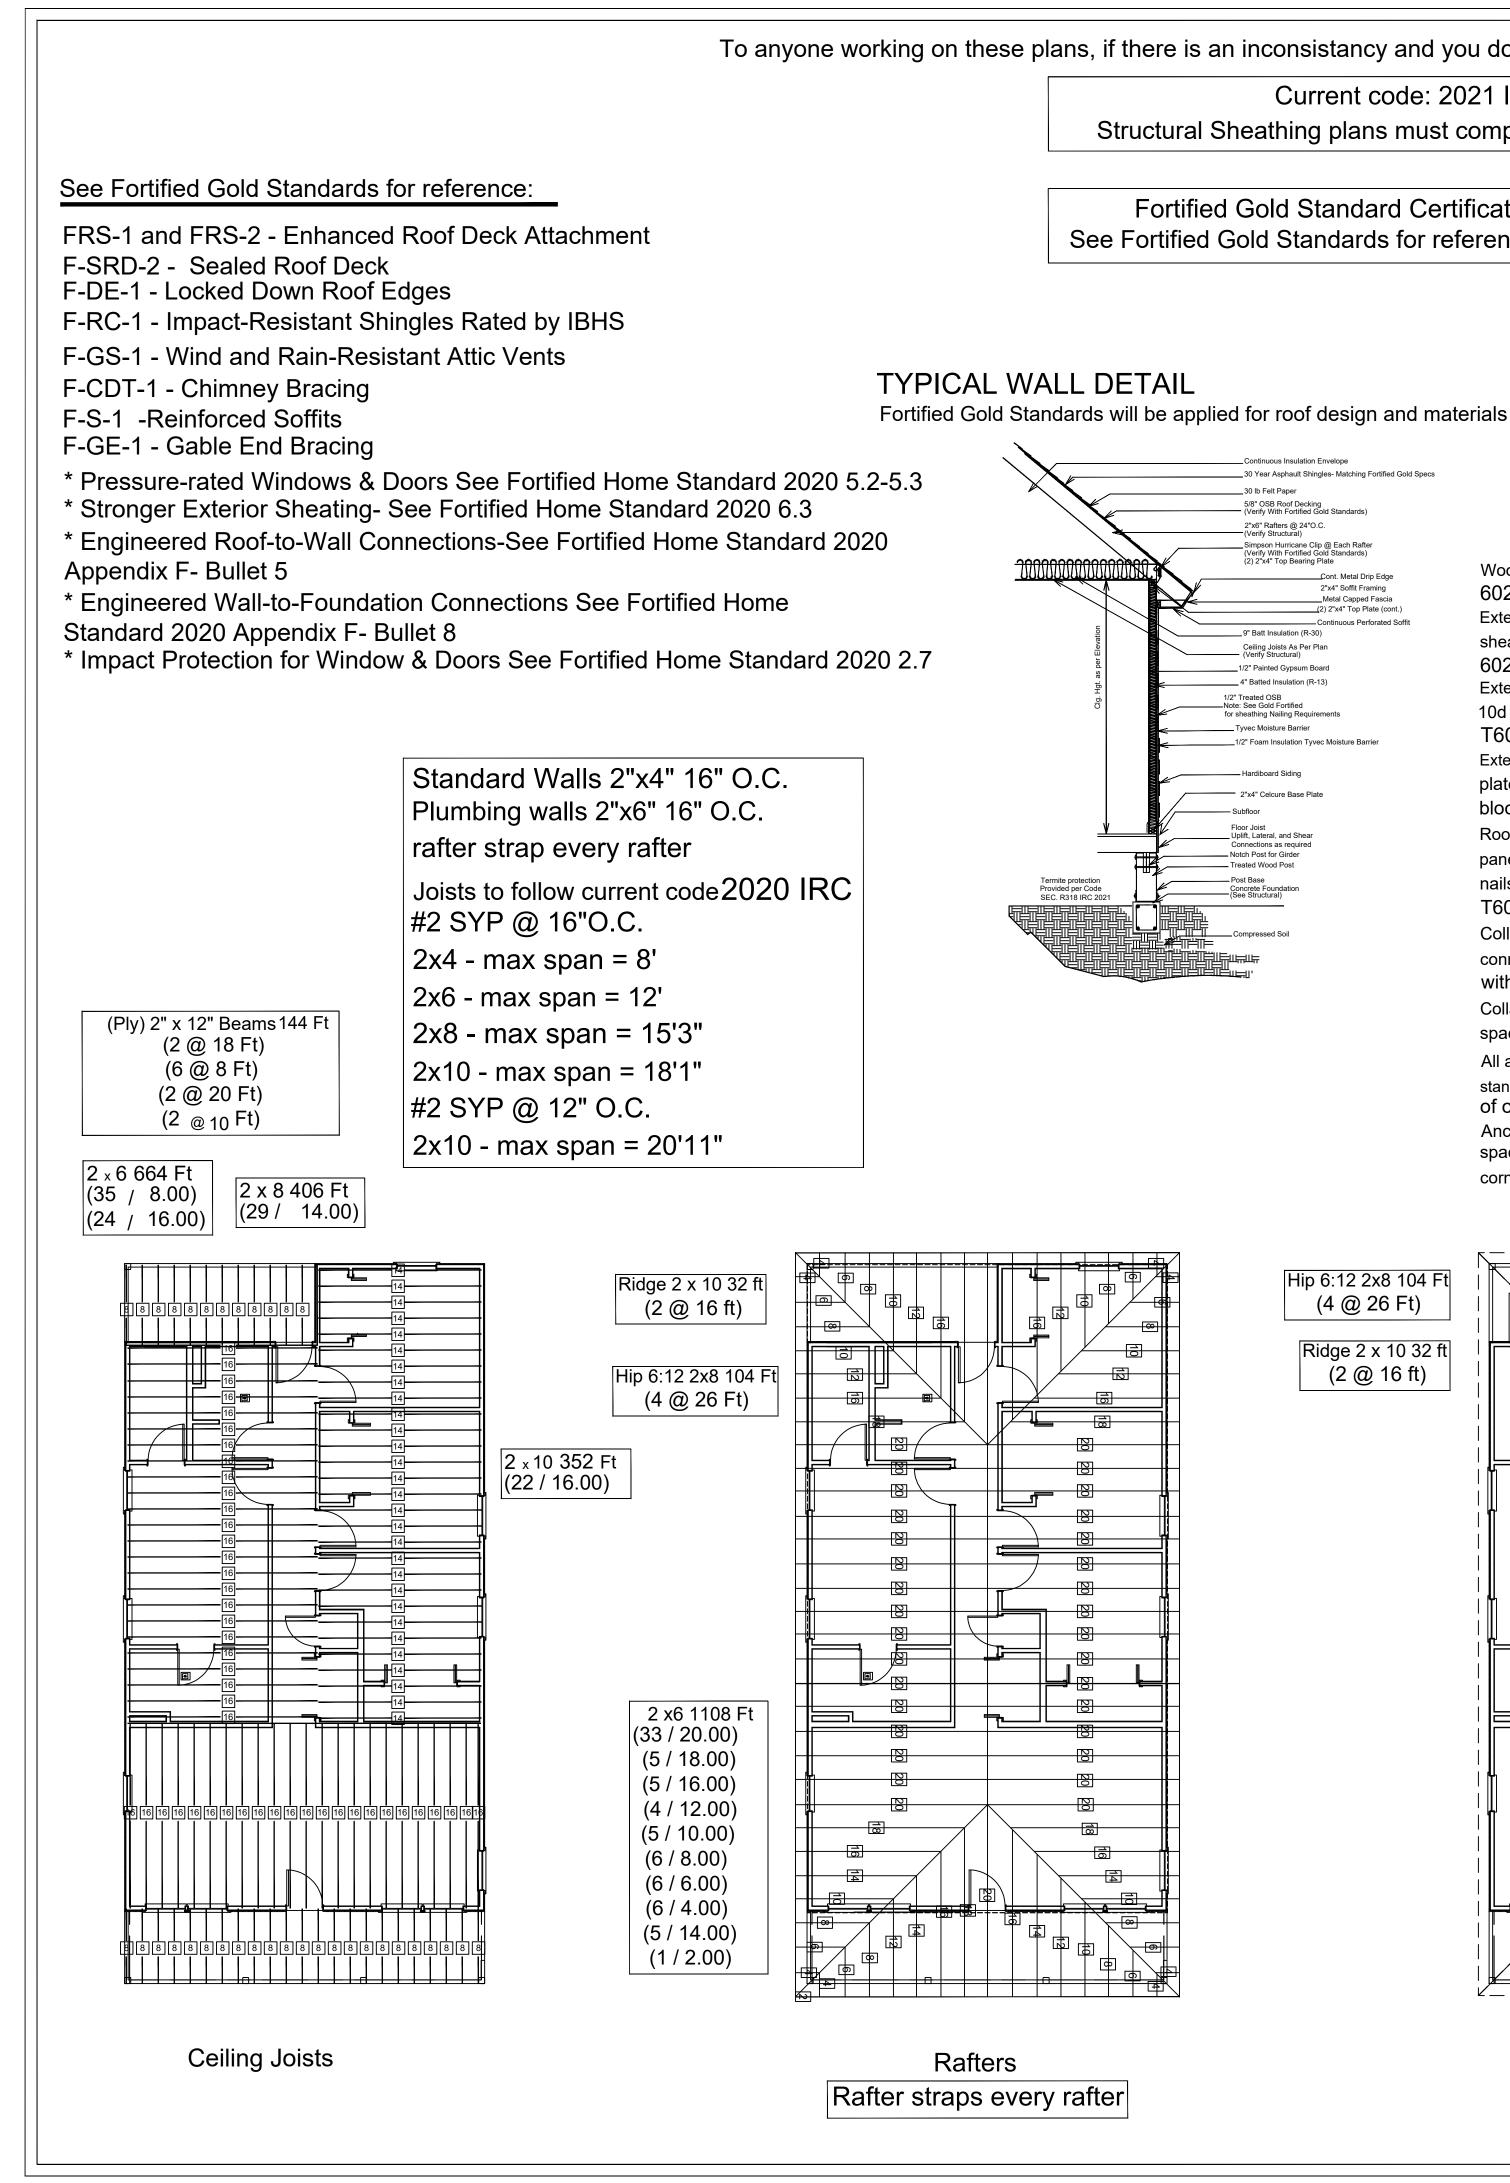

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Current code: 2021 IRC Structural Sheathing plans must comply with R503.2.1.1(1)

Fortified Gold Standard Certification is required See Fortified Gold Standards for reference -Attachments A & B

Wood stud walls to be capped with double top plate [IRC 602.3.2]

Exterior side of exterior wall, sheathing to be continuously sheathed with a minimum 7/16" wood structural panels [IRC 602.12.2]

Exterior structural wood sheathing shall be 8d common or 10d box nailed 6" o.c. at edges and 12" o.c. in the field [IRC T602.3(3)]

Exterior wall sheathing shall be continuous from bottom plate to top top-plate [IRC 602.10.2] All seams shall be block [IRC 602.10.10].


Roof sheathing shall be minimum 5/8" wood structural paneling [IRC 803.1J and shall be fastened with 6d common nails at 6" o.c. all edges and intermediate supports [IRC T602.3(1) footnote f]

Collar ties or ridge straps to resist wind uplift shall be connected in the upper third of the attic space in accordance with Table R602.3(1) [IRC 802.3.1]


Collar ties shall be not less than 1 inch by 4 inches (nominal), spaced not more than 4 feet on center [IRC 802.3.1].

All anchor bolts shall be ASTM A307 Bolts with standard hooks and shall have a minimum embedment of of 7" [IRC 403.1.6]

Anchor bolts shall be a minimum 1/2" bolt w/washer spaced no greater than 6' o.c. and within 12" of each corner [IRC 403.1.6]

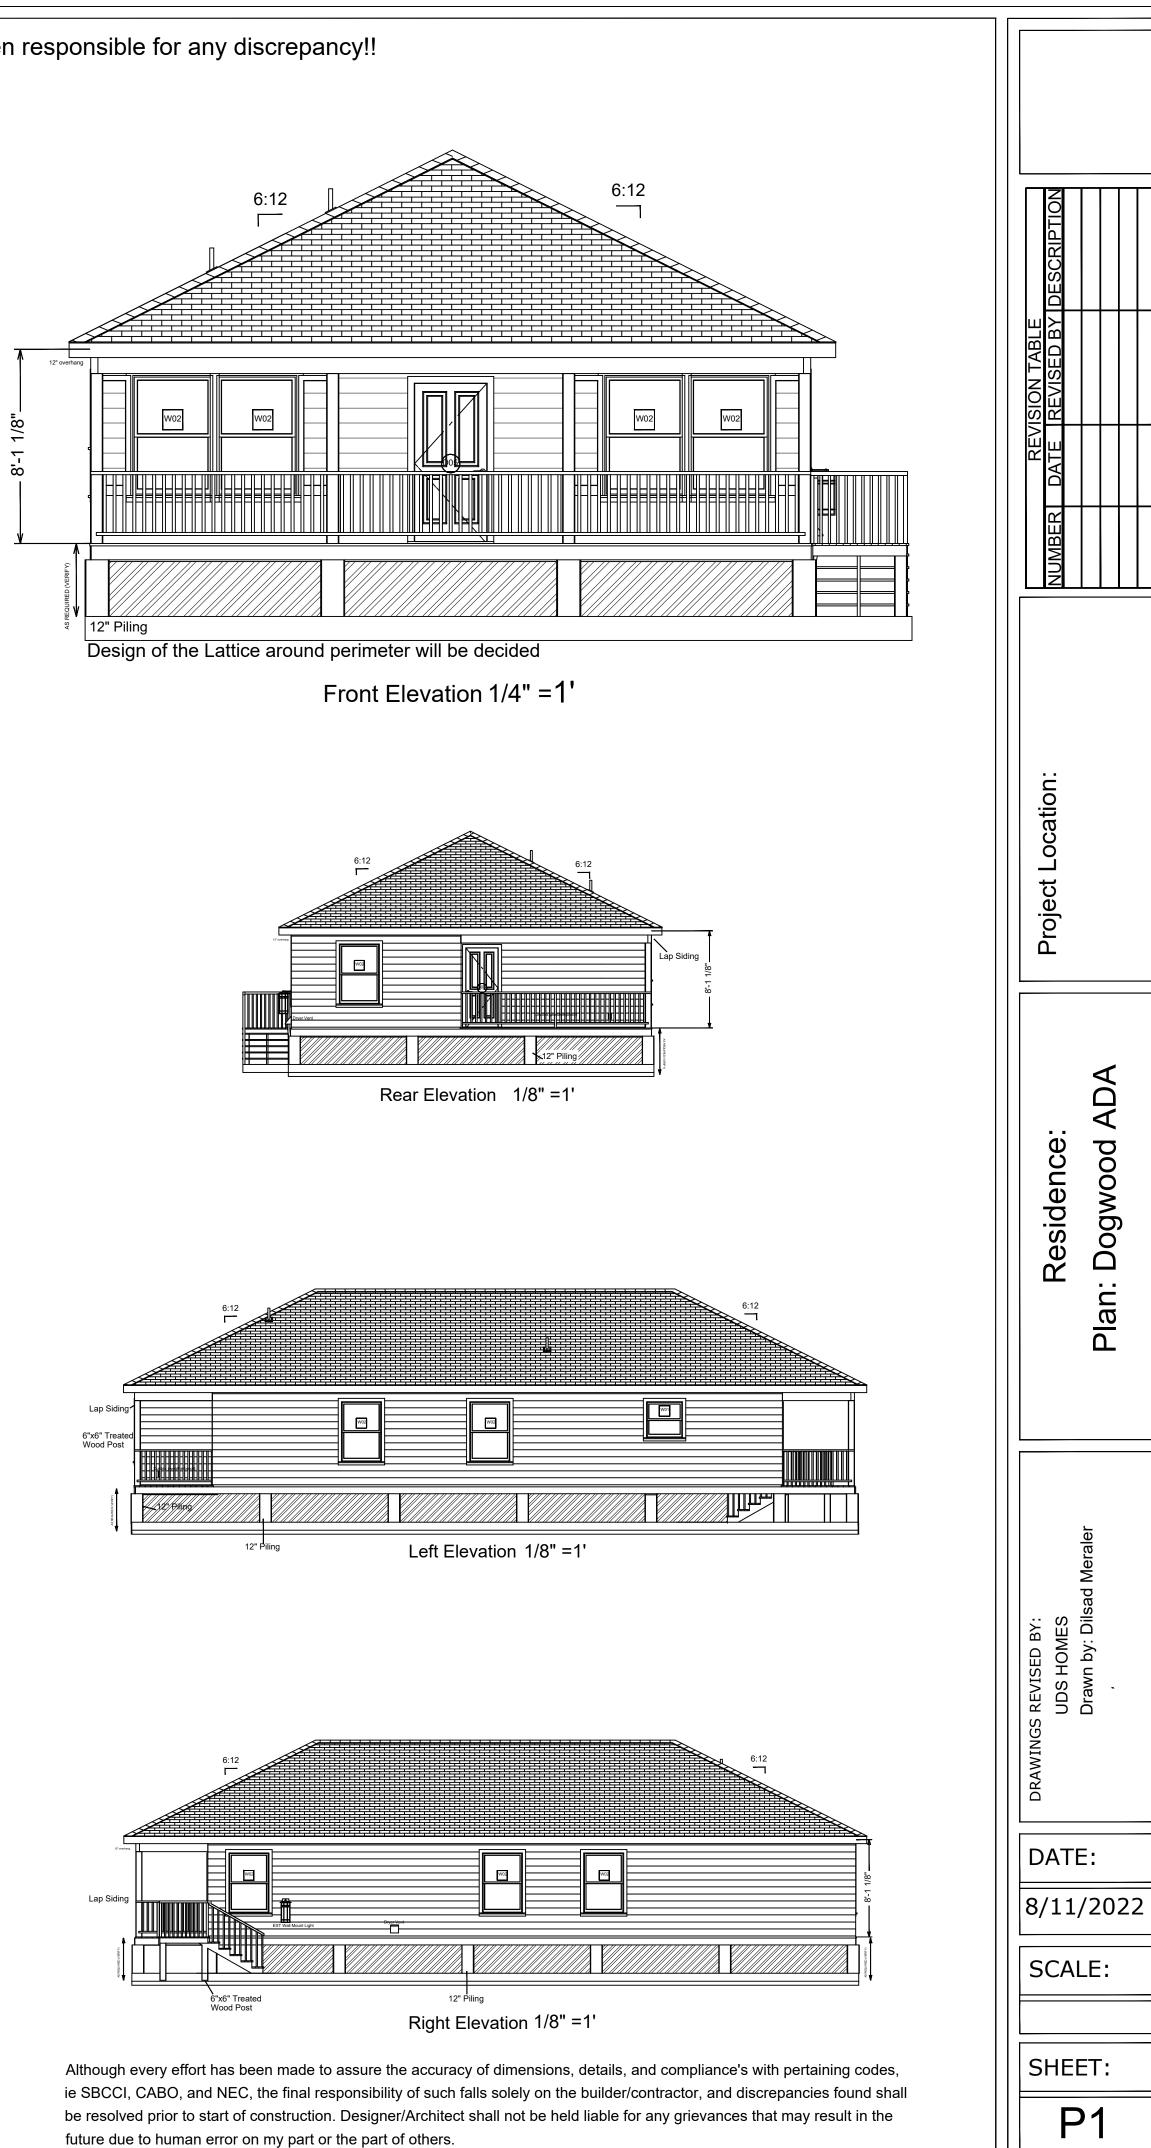




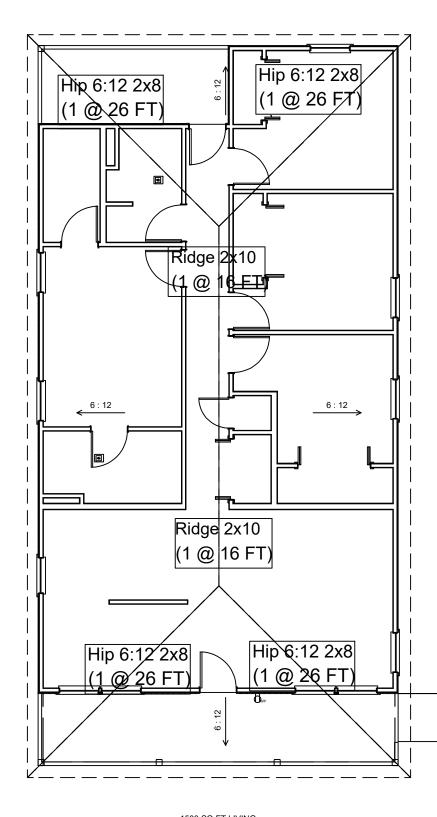


1500 SQ FT LIVING 182 SQ FT FRONT PORCH 106 SQ FT REAR PORCH 1788 SQ FT UB (TOTAL)

Roof Plan 1/8" =1'



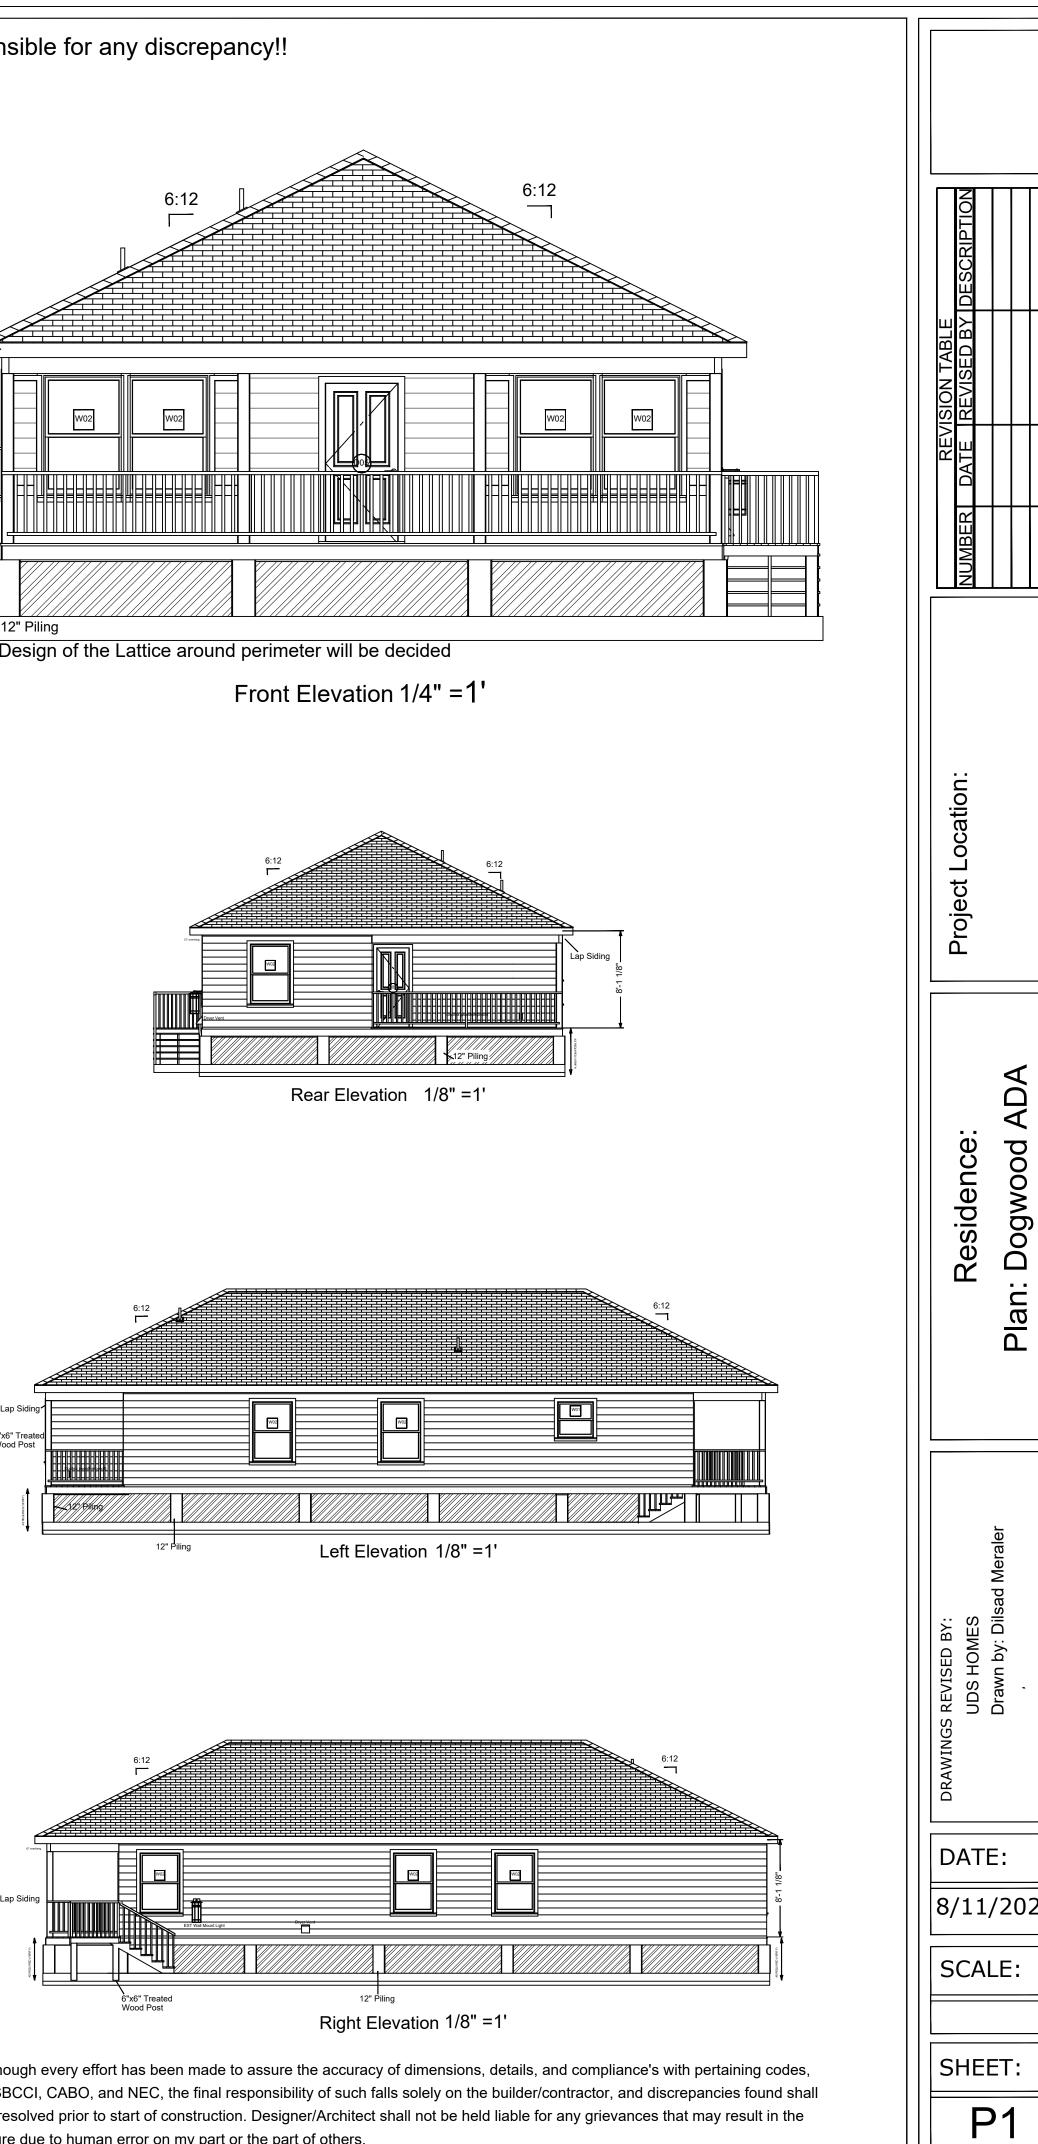

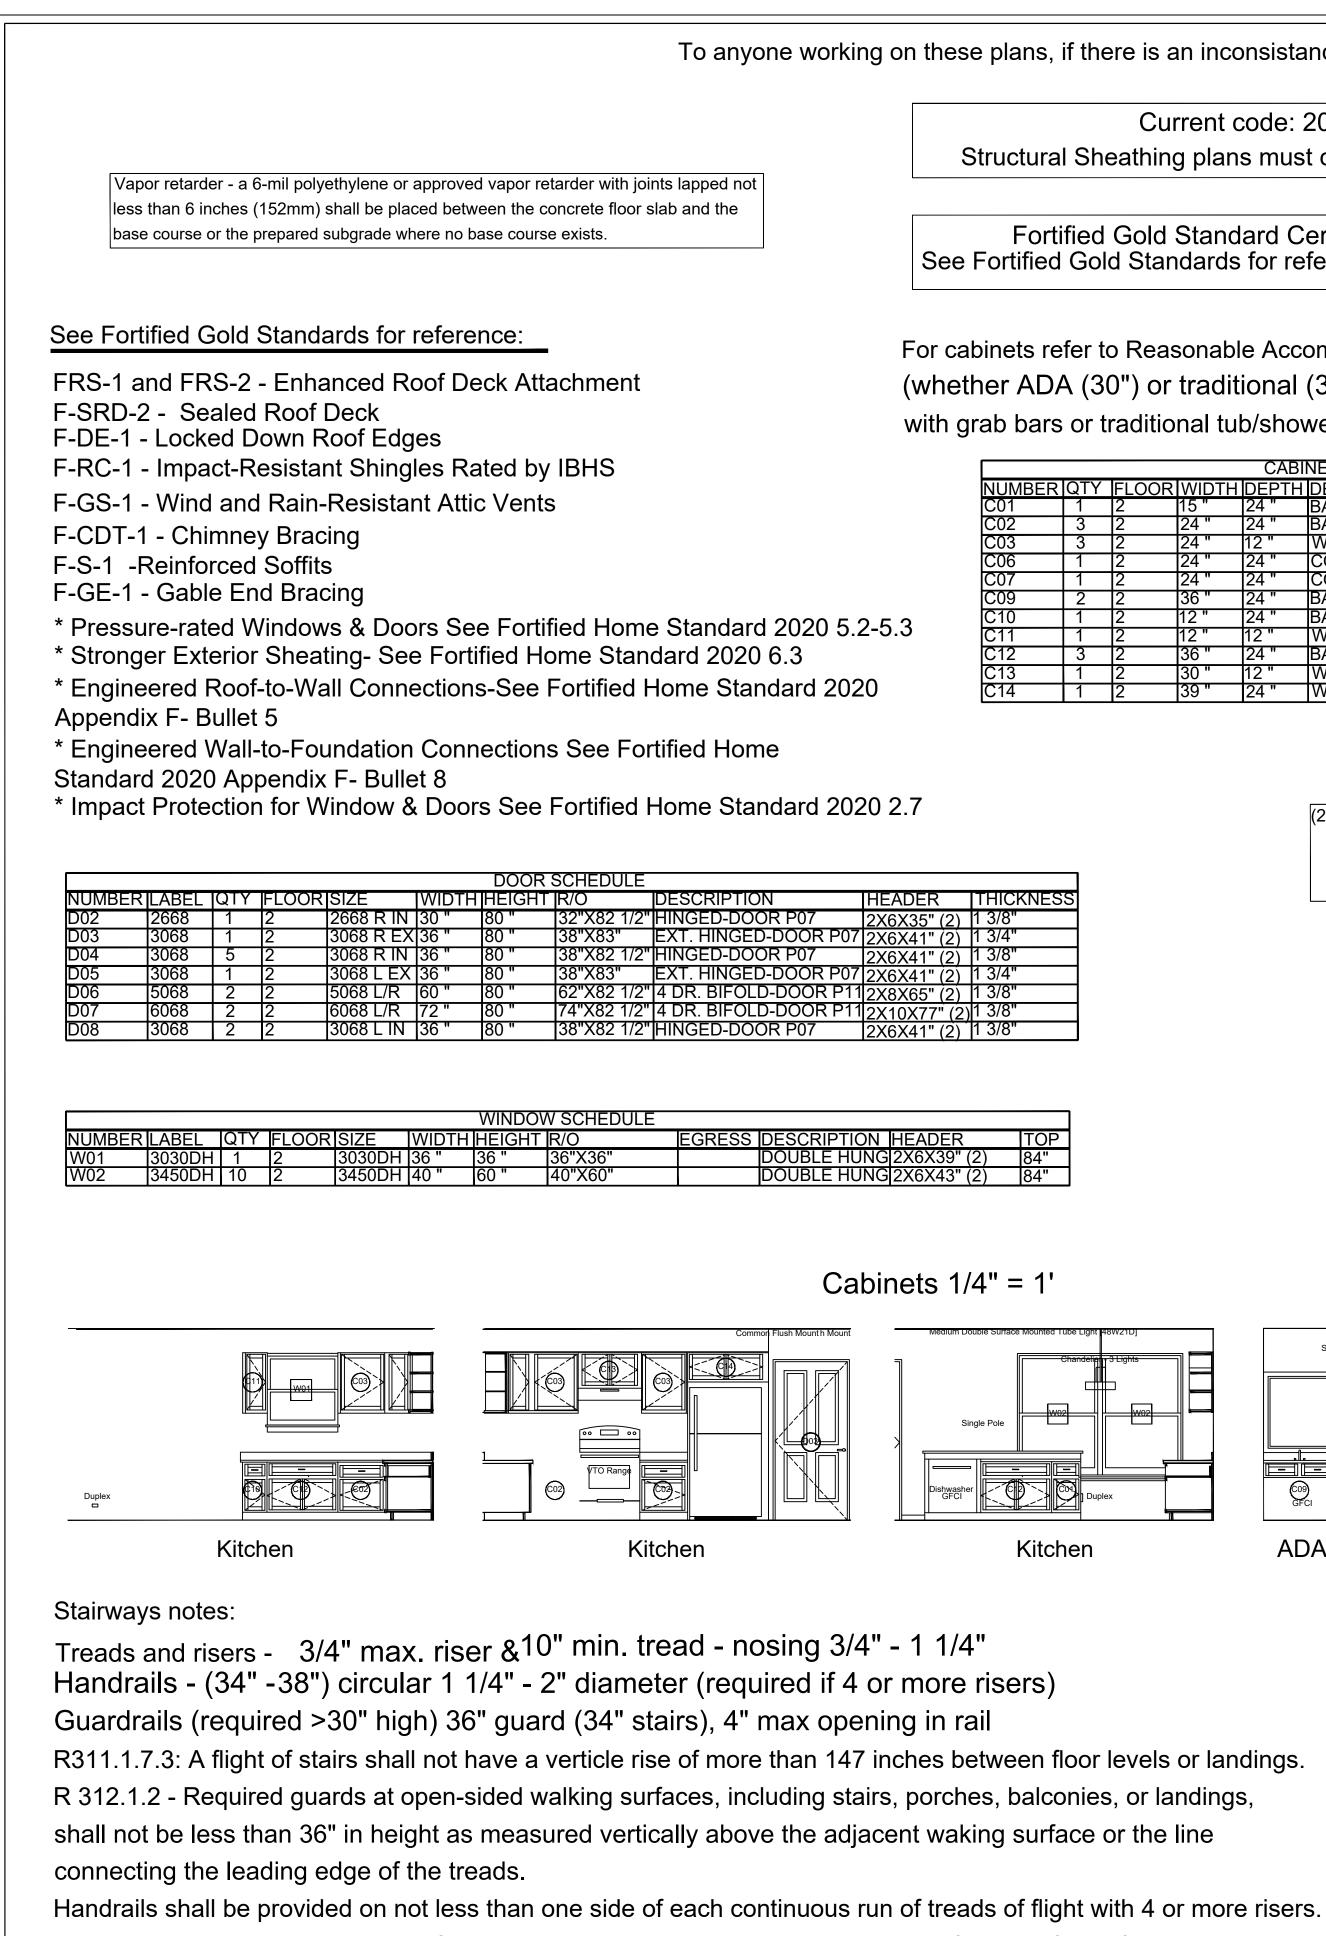

not be less than 34" and not more than 38". Landings for stairways - There shall be a floor or landing at the top and bottom of each stairway. the width perp. to direction of travel shall not be less than the width of the flight served. The depth of direction of travel shall not

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For cabinets refer to Reasonable Accommodation Sheet to determine base cabinet height (whether ADA (30") or traditional (36"). Also will determine whether ADA showers with grab bars or traditional tub/shower combos will be used.

| | | | | CABII | NET SCHEDULE | ADA | STD |
|---|-----|-------|-------|-------|---------------------|--------|--------|
| R | QTY | FLOOR | WIDTH | DEPTH | DESCRIPTION | HEIGHT | HEIGHT |
| | 1 | 2 | | | BASE CABINET | 30 " | 36 |
| | 3 | 2 | 24 " | | BASE CABINET | 30 " | 36" |
| | 3 | 2 | | 12 " | WALL CABINET | 30 " | |
| | 1 | 2 | 24 " | 24 " | CORNER BASE CABINET | 30 " | 36" |
| | 1 | 2 | 24 " | 24 " | CORNER WALL CABINET | 30 " | 36" |
| | 2 | 2 | | | BASE CABINET | 30 " | |
| | 1 | 2 | | | BASE CABINET | 30 " | 36" |
| | 1 | 2 | | 12 " | WALL CABINET | 30 " | |
| | 3 | 2 | 36 " | 24 " | BASE CABINET | 30 " | |
| | 1 | 2 | | 12 " | WALL CABINET | 18 " | |
| | 1 | 2 | 39 " | 24 " | WALL CABINET | 15 " | |

(2 Ply) 2"x12" Beams 144 Ft

(2 @ 18 Ft)

(6 @ 8 Ft)

(2 @ 20 Ft) (2 @ 10 Ft)

Sconce


ADA Bath 1

Sconce ≝

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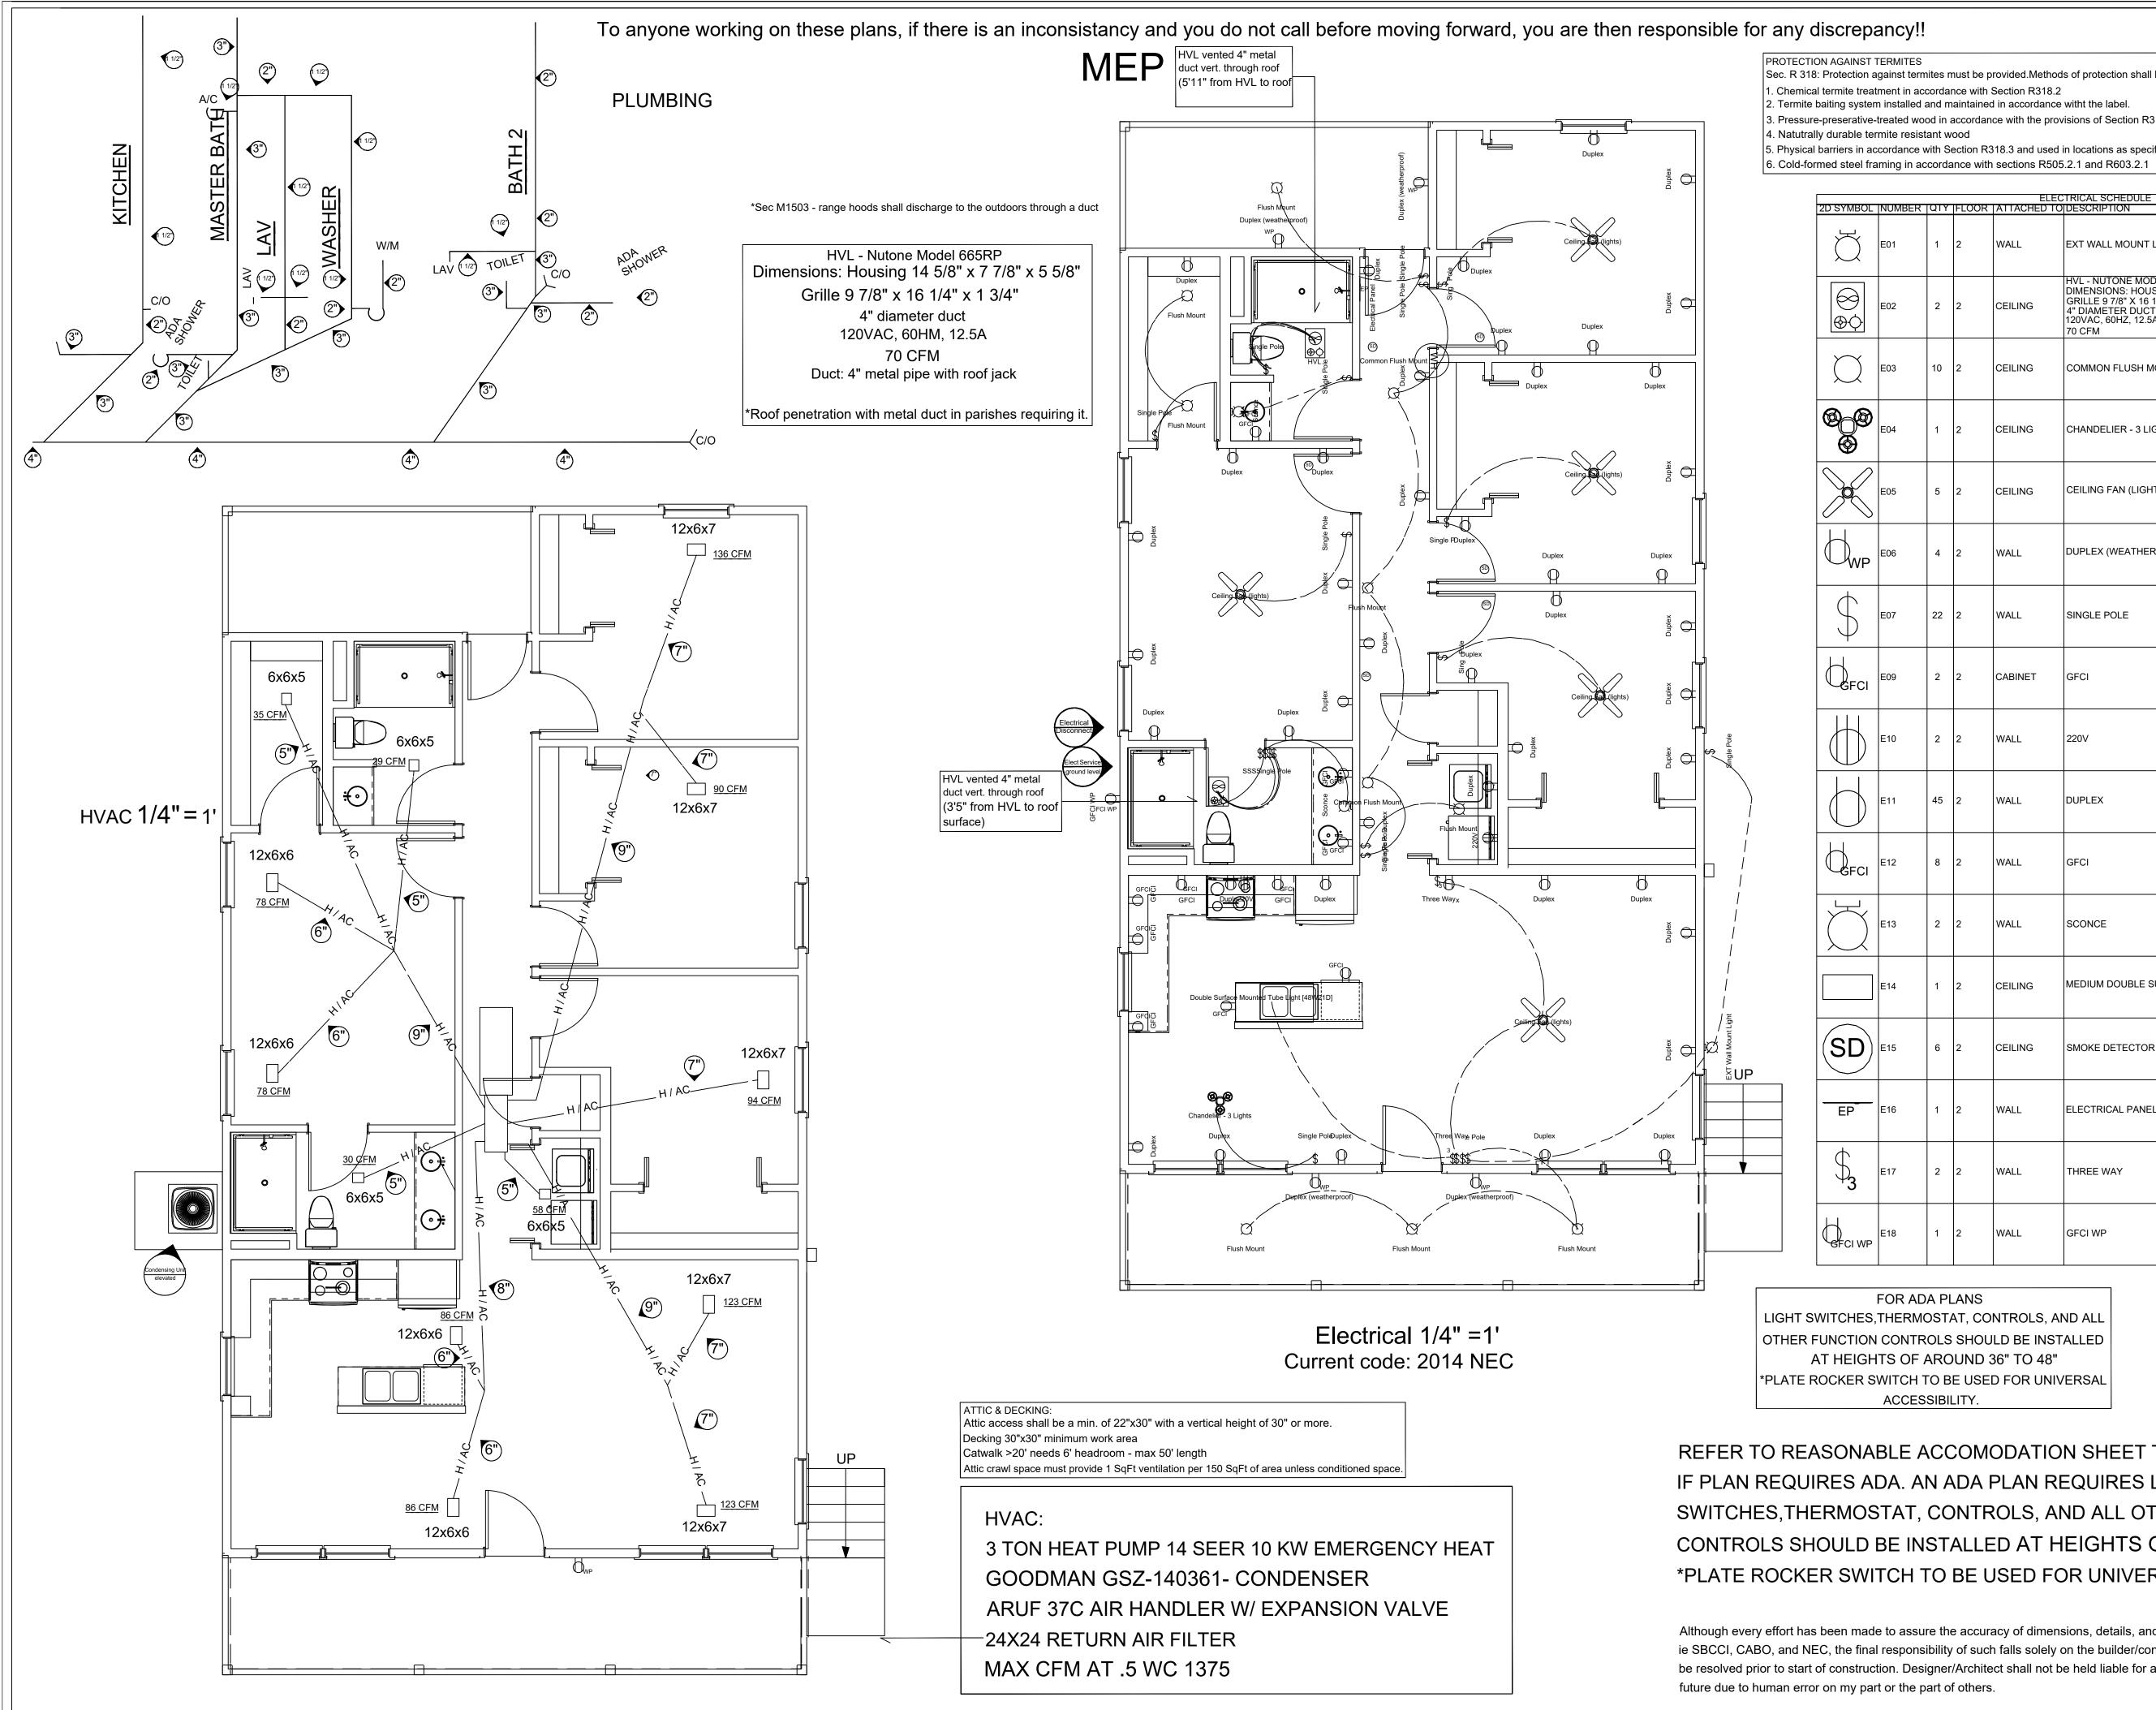
ADA Bath 2

Handrail height measured vertially from sloped plne adjoining the tread nosing, or finish surface of ramp slope, shall



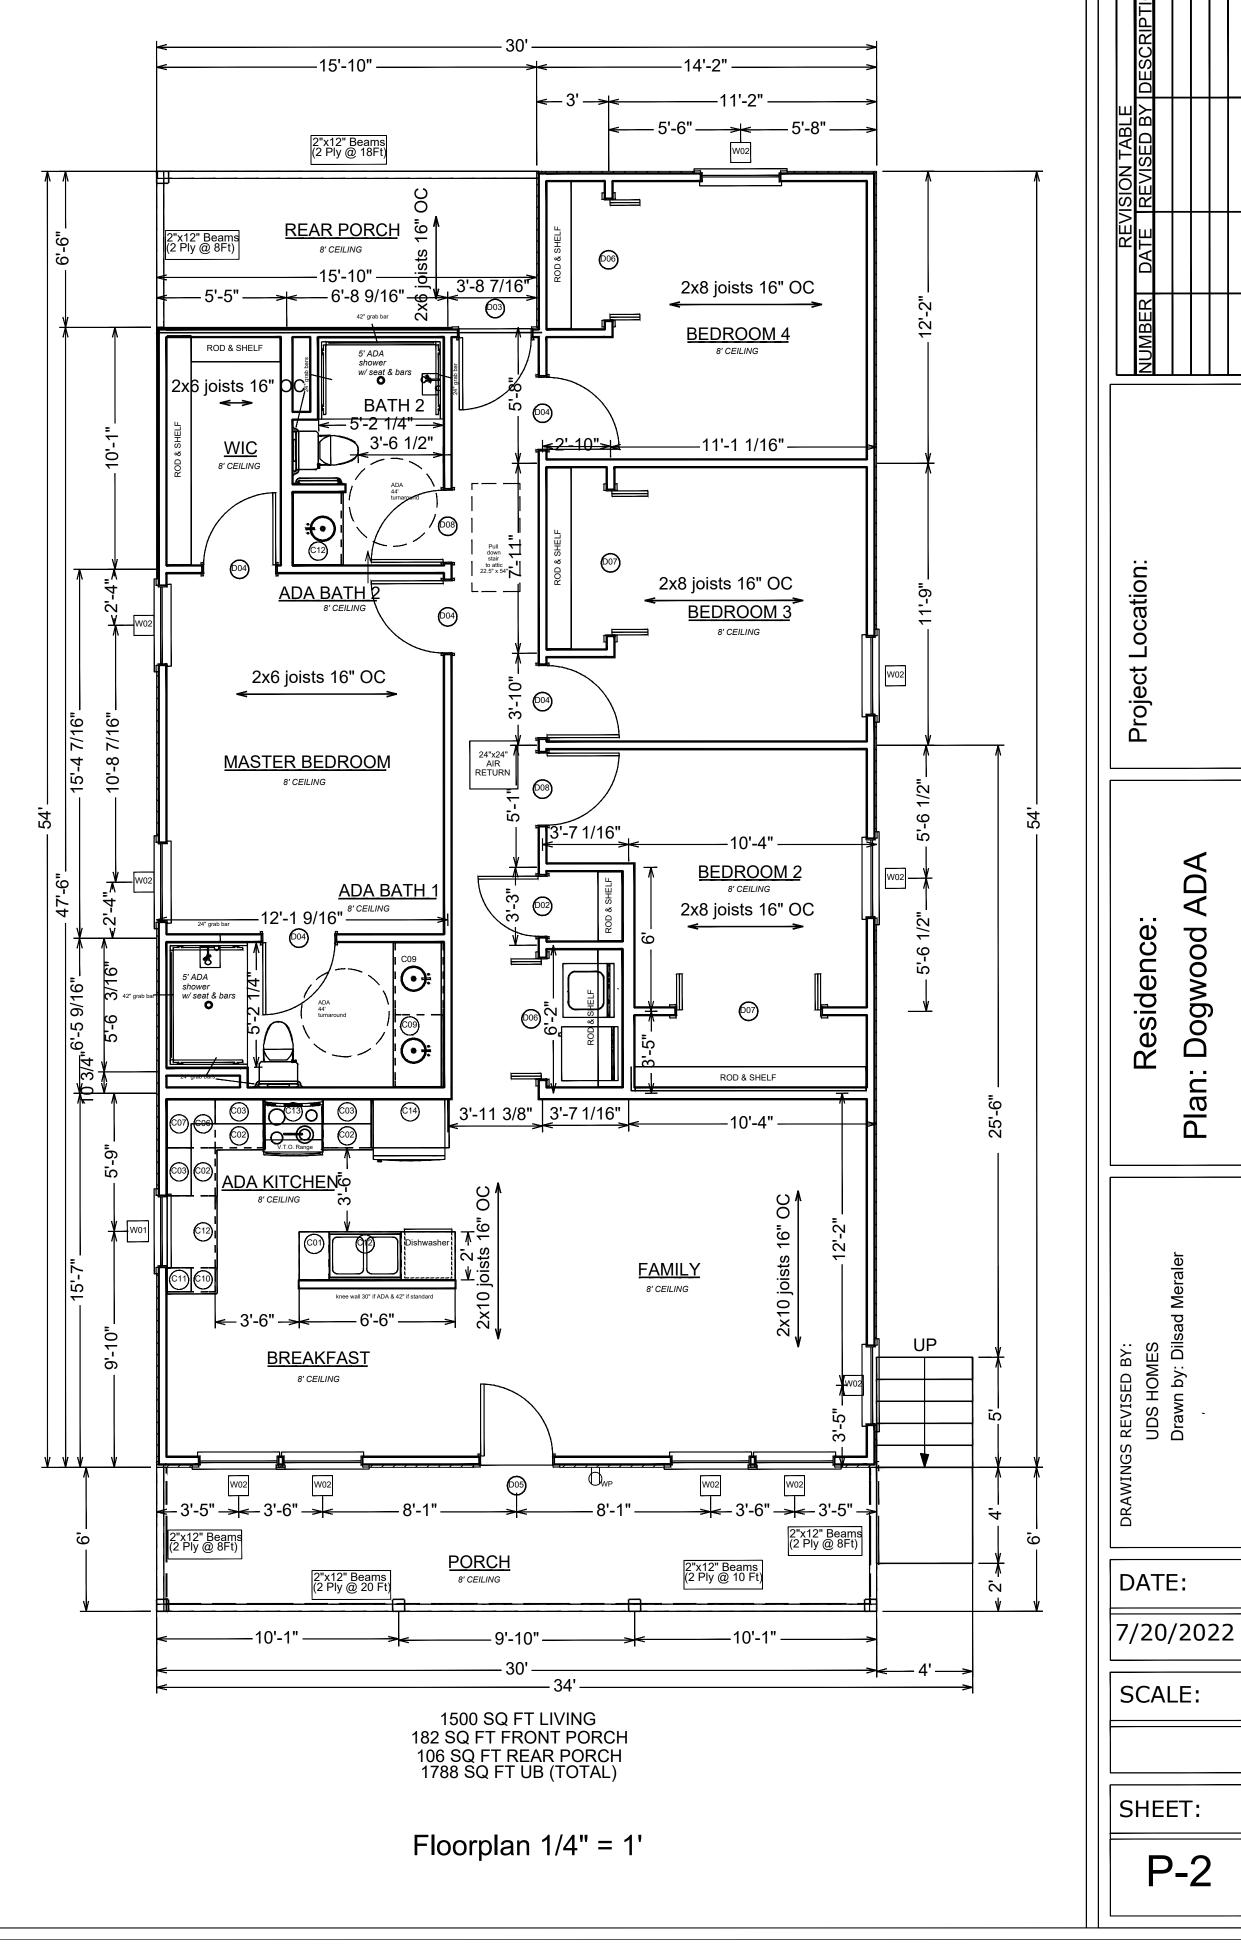

Although every effort has been made to assure the accuracy of dimensions, details, and compliance's with pertaining codes, ie SBCCI, CABO, and NEC, the final responsibility of such falls solely on the builder/contractor, and discrepancies found shall be resolved prior to start of construction. Designer/Architect shall not be held liable for any grievances that may result in the future due to human error on my part or the part of others.



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| screpancy!! | |
|-------------|--|
|-------------|--|

PROTECTION AGAINST TERMITES

Sec. R 318: Protection against termites must be provided.Methods of protection shall be one, or a combinaion of the following methods: I. Chemical termite treatment in accordance with Section R318.2 2. Termite baiting system installed and maintained in accordance witht the label.

Pressure-preserative-treated wood in accordance with the provisions of Section R317.1

5. Physical barriers in accordance with Section R318.3 and used in locations as specified in Section R317.1

| | | | | FLEC | TRICAL SCHEDULE | |
|-----------------------|--------|-----|-------|-------------|--|------|
| D SYMBOL | NUMBER | QTY | FLOOR | ATTACHED TO | | CODE |
| Ŋ | E01 | 1 | 2 | WALL | EXT WALL MOUNT LIGHT | |
| (2) | E02 | 2 | 2 | CEILING | HVL - NUTONE MODEL 665RP DIMENSIONS: HOUSING 14 5/8" X 7 7/8" X 5 5/8" GRILLE 9 7/8" X 16 1/4" X 1 3/4" 4" DIAMETER DUCT 120VAC, 60HZ, 12.5A 70 CFM | |
| \square | E03 | 10 | 2 | CEILING | COMMON FLUSH MOUNT | |
| <u>&</u> @ | E04 | 1 | 2 | CEILING | CHANDELIER - 3 LIGHTS | |
| | E05 | 5 | 2 | CEILING | CEILING FAN (LIGHTS) | |
| H _{WP} | E06 | 4 | 2 | WALL | DUPLEX (WEATHERPROOF) | |
| \$ | E07 | 22 | 2 | WALL | SINGLE POLE | |
| GFCI | E09 | 2 | 2 | CABINET | GFCI | |
| | E10 | 2 | 2 | WALL | 220V | |
| | E11 | 45 | 2 | WALL | DUPLEX | |
| GFCI | E12 | 8 | 2 | WALL | GFCI | |
| | E13 | 2 | 2 | WALL | SCONCE | |
| | E14 | 1 | 2 | CEILING | MEDIUM DOUBLE SURFACE MOUNTED TUBE LIGHT [48W21D |) |
| SD | E15 | 6 | 2 | CEILING | SMOKE DETECTOR | |
| EP | E16 | 1 | 2 | WALL | ELECTRICAL PANEL | |
| \$3 | E17 | 2 | 2 | WALL | THREE WAY at end of hall | |
| GECI WP | E18 | 1 | 2 | WALL | GFCI WP | |
| | | | | | | |


FOR ADA PLANS

LIGHT SWITCHES, THERMOSTAT, CONTROLS, AND ALL OTHER FUNCTION CONTROLS SHOULD BE INSTALLED AT HEIGHTS OF AROUND 36" TO 48" *PLATE ROCKER SWITCH TO BE USED FOR UNIVERSAL ACCESSIBILITY.

| SONABLE ACCOMODATION SHEET TO DETERMINE |
|--|
| ES ADA. AN ADA PLAN REQUIRES LIGHT |
| RMOSTAT, CONTROLS, AND ALL OTHER FUNCTION |
| ULD BE INSTALLED AT HEIGHTS OF AROUND 36" TO 48" |
| R SWITCH TO BE USED FOR UNIVERSAL ACCESSIBILITY. |

| NUMBER DATE REVISION TABLE NUMBER DATE REVISED BY DESCRIPTION | |
|--|--|
| Project Location: | |
| Residence: Plan: Dogwood ADA | |
| DRAWINGS REVISED BY: UDS HOMES Drawn by: Dilsad Meraler | |
| DATE: 7/20/2022 SCALE: | |
| SHEET: P3 | |




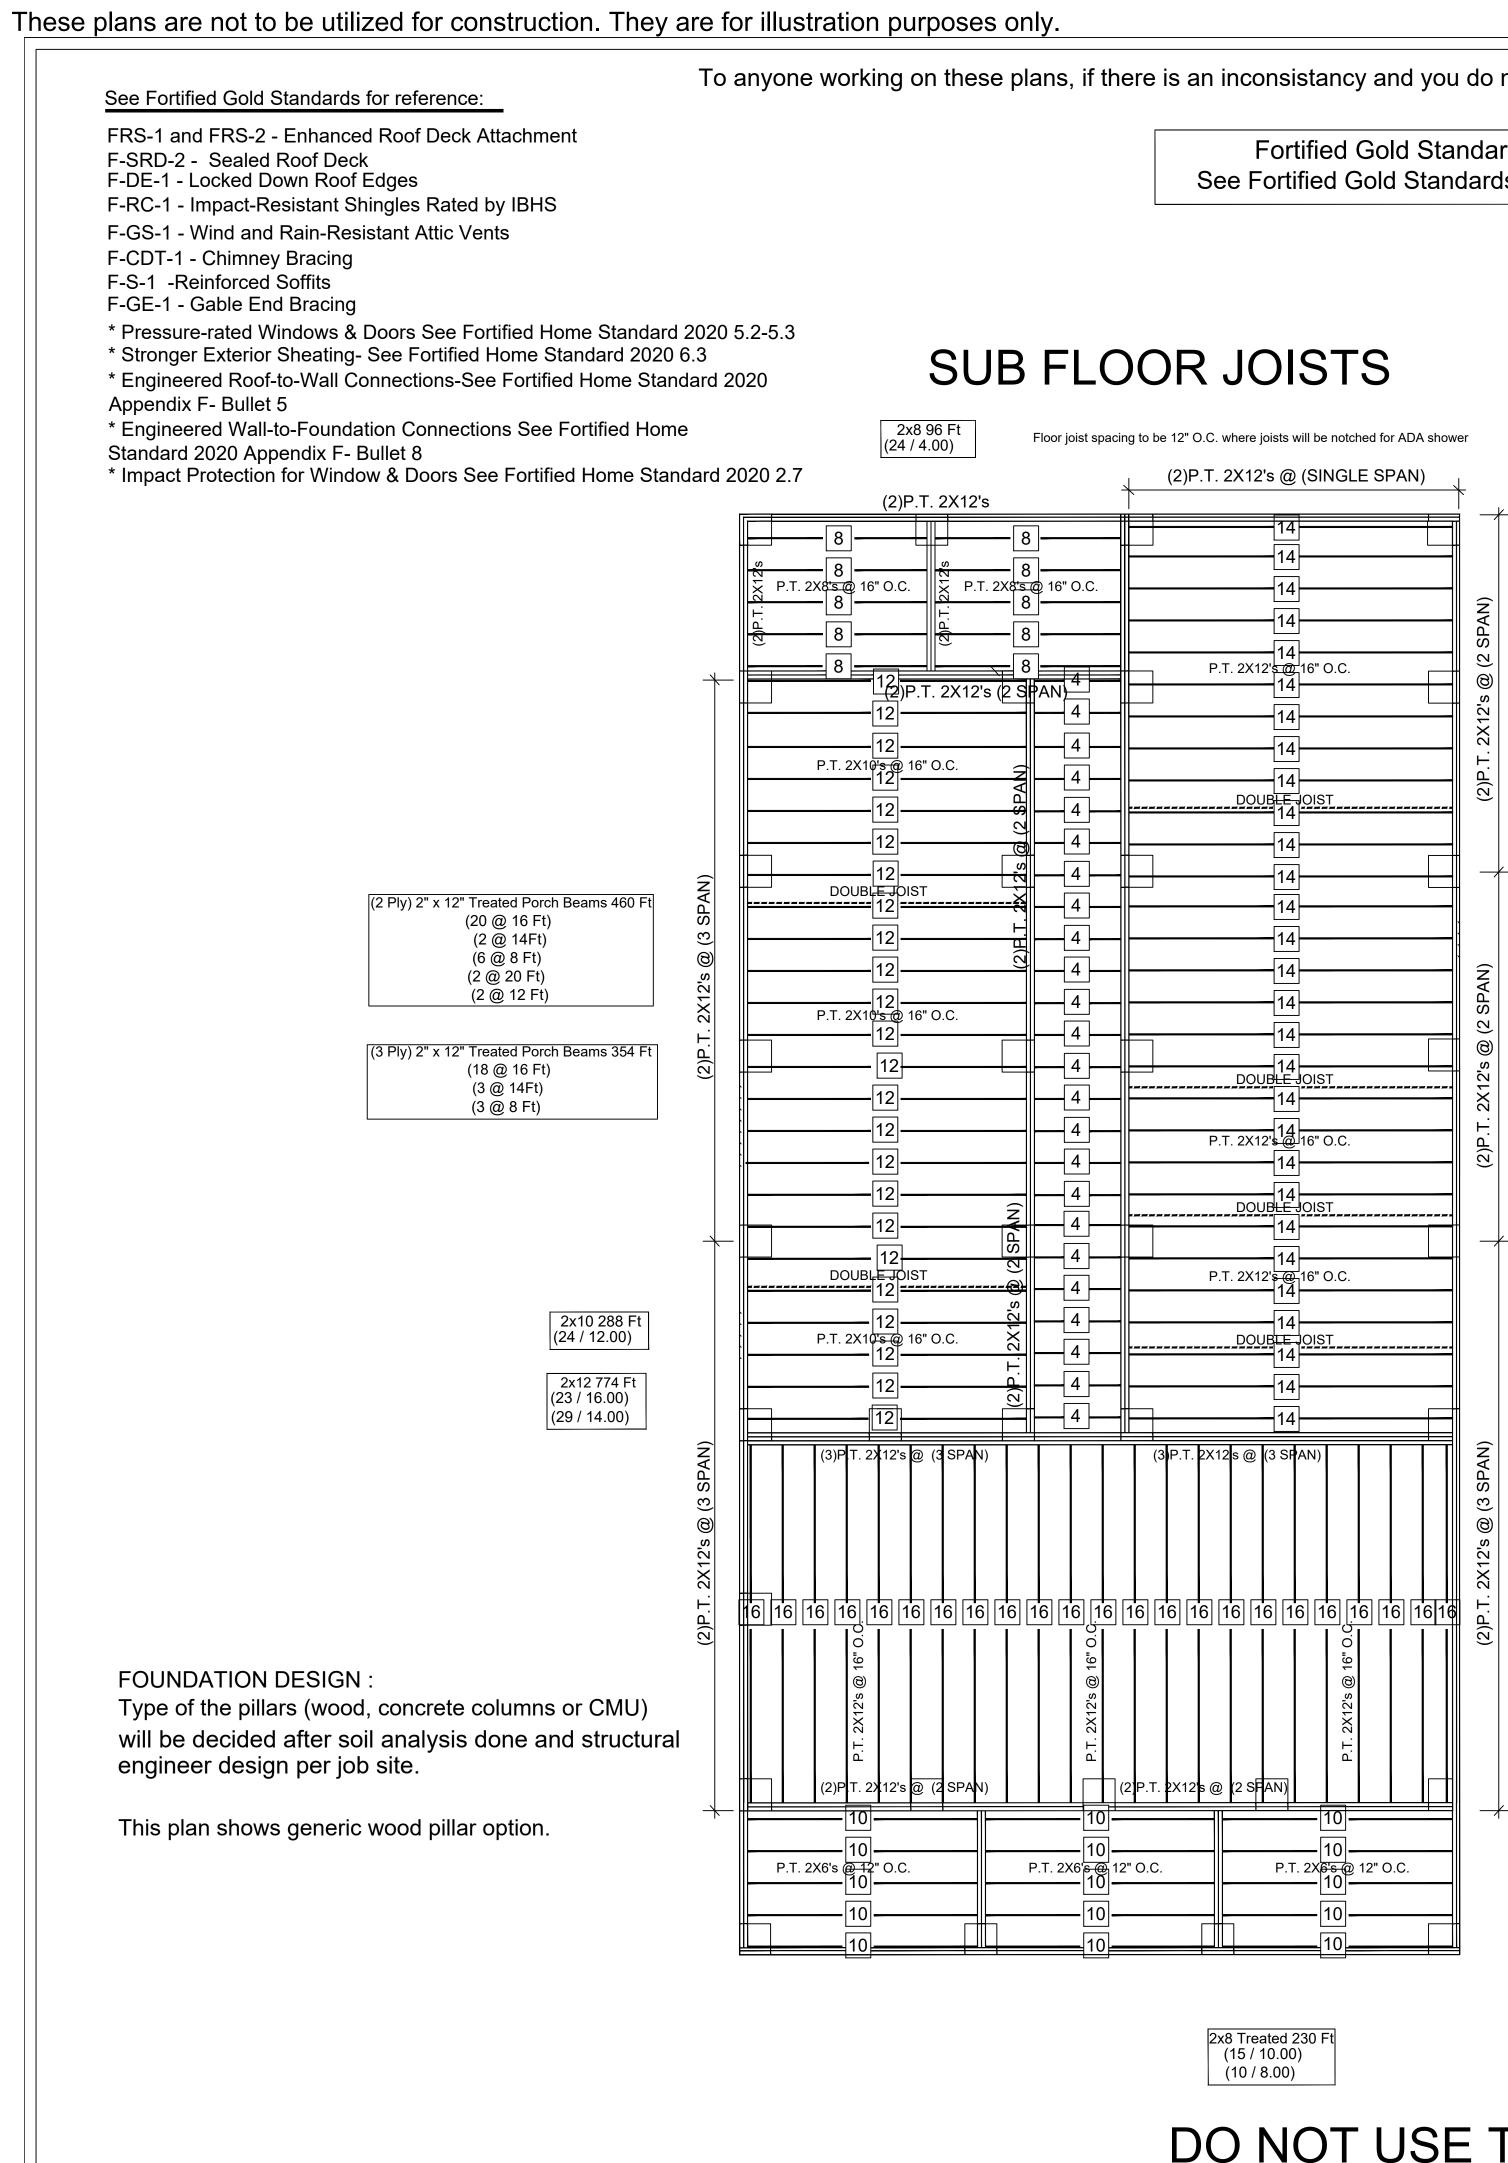

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TREATED SILLS



DO NOT USE THIS TO SET FORMS!
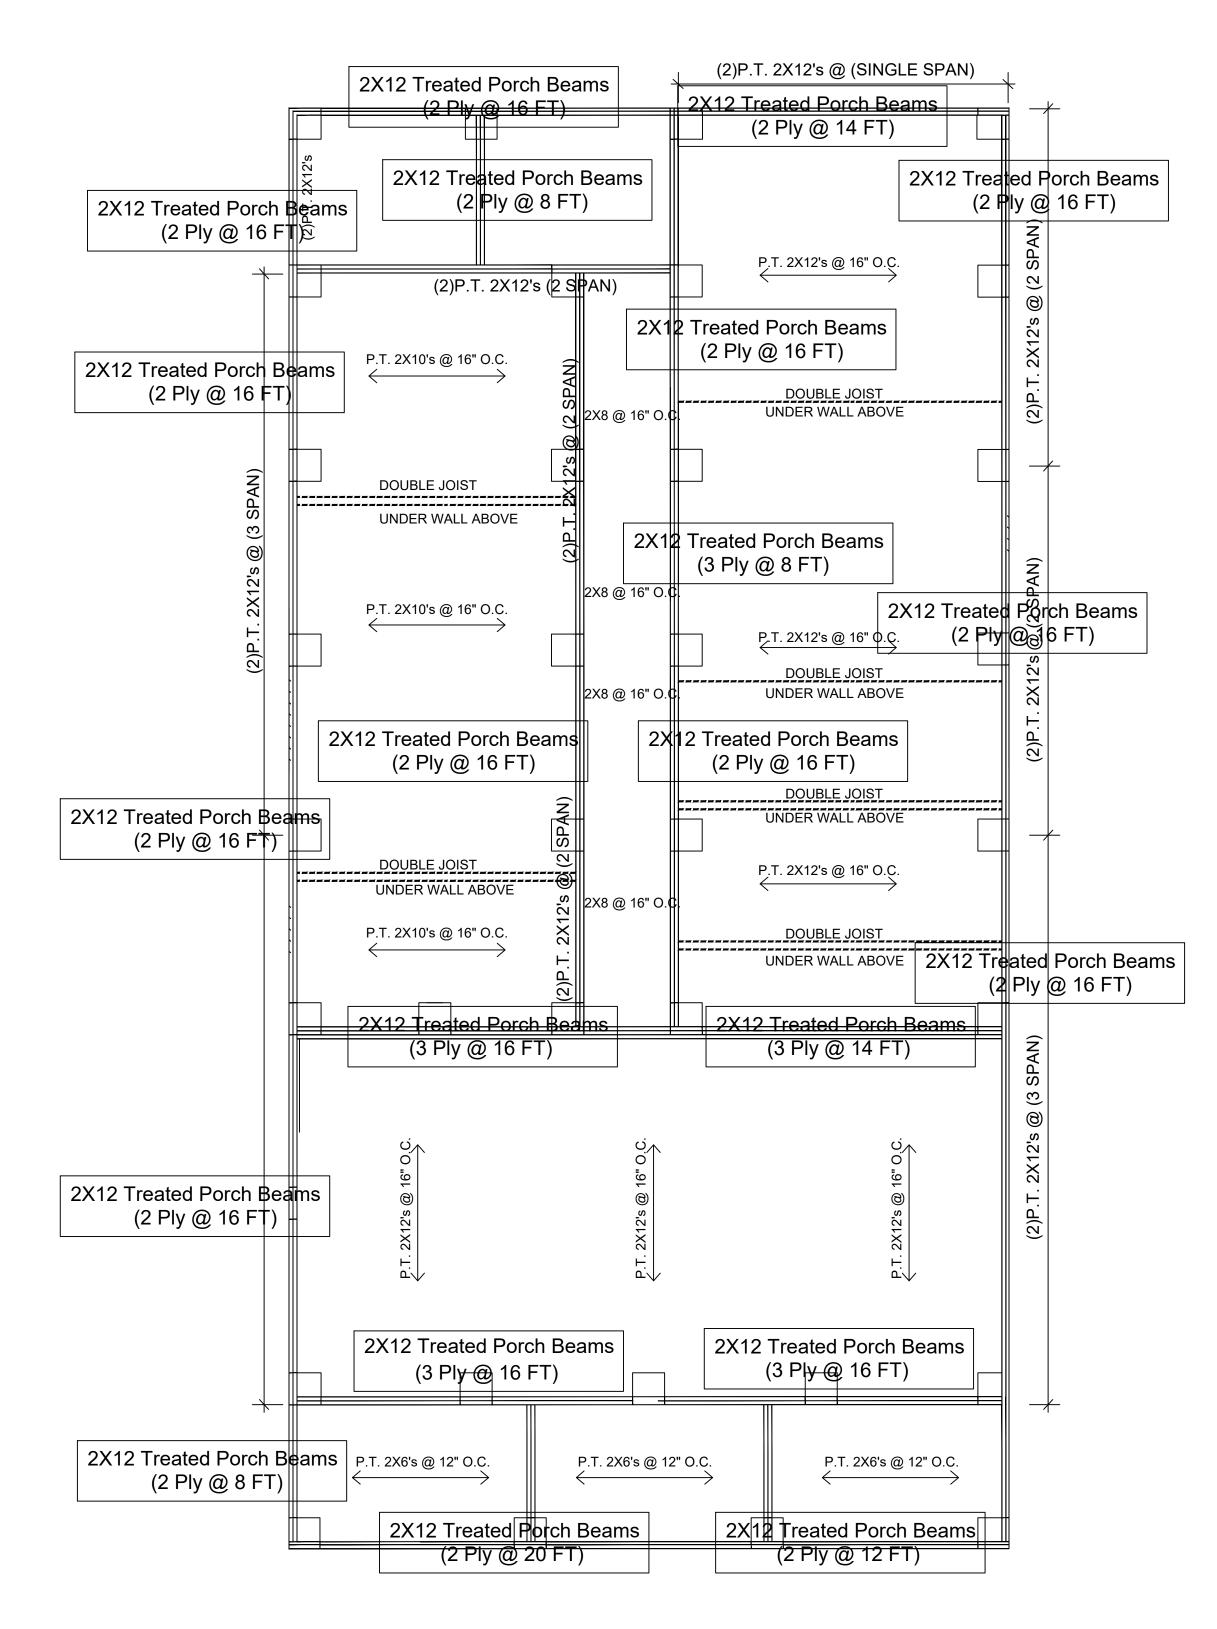
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